

FOUNDATIONS:
-ALL FOUNDATIONS TO COMPLY WITH SANS10400 PART G&H -4.4.1
-ALL FOUNDATIONS TO BE NOT LESS THAN 25 MPa AT 28 DAYS.
-FOUNDATIONS TO ALL 230mm WALLS TO BE 700mmX280mm OR TO ENGINEER
SPECIFICATIONS
-REINEODOLO -

REINFORCING STEEL TO BE INSERTED IN FOUNDATIONS AND FLOOR SLAB THICKENINGS IF NECESARY OR AS PER ENGINEERS SPECIFICATIONS.

WALL CONSTRUCTION:
TO COMPLY WITH SANS 10400 PART-R, 10400XA-4.4.3
-MAXI CEMENT BRICKS SHALL COMPLY WITH SABS 10400 PART KK3 & KK4
-BRICKFORGE TO BE PROVIDED AFTER EVERY FOURTH(4) BRICK COURSE AND
EVERY SECOND COURSE ABOVE ALL OPENINGS.
-WALL TIES TO BE EVENLY DISTRIBUTED AT 2.5 TIES/m².
-MOVEMENT/CONTROL JOINTS TO BE FILLED IN WITH APPROVED BITUMEN
IMPREGNATED BOARD OR EXPANDED POLYETHYLENE STRIPS UNLESS OTHERWISE

SPECIFIED.

-WEEPHOLES TO BE PROVIDED @ MIN. 690mm C/C,

-PREFABRICATED PRE STRESSED CONCRETE LINTELS TO BE USED OVER ALL. OPENINGS EXCEEDING 600mm AND LAID TO MANUFACTURES SPECIFICATIONS.
-375 MIC DPC OVER ALL DOORS AND WINDOW SIDES, HEADS AND SILLS.
-INTERNAL WALLS TO BE SMOOTH PLASTERED PAINTED WHITE, GARAGE WALLS

TO BE BAGGED.
-EXTERNAL WALLS TO BE SMOOTH PLASTERED AND PAINTED AS INDICATED ON ELEVATIONS,
- TO REGULATION XA COMPLIANCE REPORT

GLAZING:
- TO COMPLY WITH SANS 10137, SANS 10400 PART N, SANS 204 & SANS 10400-XA
- ALL GLAZING WITHIN 500MM OF THE FFL TO BE SAFETY GLASS
- ALL GLAZING IN DOORS TO BE SAFETY GLASS
- ALL GLAZING WITHIN 1000mm OF DOORS TO BE SAFETY GLASS.

ALL GLAZING EXCEEDING 1m2 AND LOWER THAN 500mm FROM FFL TO BE SAFETY

-ALL BATHROOMS TO HAVE OBSCURE GLASS - TO REGULATION XA COMPLIANCE REPORT

FLOOR COVERING: - FINISH AS INDICATED ON FLOOR PLAN OR AS PER OWNER'S SPECIFICATION ON 100mm CONCRETE 25 Mpa REINFORCED WITH 193 WELDED MESH ON 250mic DAMP PROOF MEMBRANE ON WELL COMPACTED FILL WHICH MUST BE FREE FROM CLAY OR ANY OTHER ORGANIC MATERIALS.

TO REGULATION XA COMPLIANCE REPORT

RAINWATER GOODS:
- Light Grey "D" SHAPE 75mm@ GUTTERS TO BE USED FOR COLLECTION FROM ROOF AREAS

ALL PVC/SEAMLESS ALUMINIUM GUTTERS TO FITTED BY SPECIALIST.

- 75mm DIAMETER Light Grey DOWN PIPES FIXED TO FACIA WITH HOLDER BATS @

STORMWATER TO THE STREET VIA WATER CHANNEL OR REMAIN ON THE PLOT.
MAKE PROVISION THAT NO WATER MOVE TO PLOTS ENCROACHED TO COMPLY WITH SANS 10400R (SECTION R OF NBR AND BS ACT 103,1977.

SPLASH BACK TILES @ BATH, SHOWER, STOVE, SINK, NO SPLASH BACK BEHIND BASINS, REFER TO SPECIFICATION LIST.

DRAINAGE:
- ALL DRAINAGE(IL'S, CL'S) AND SW TO BE CONFIRMED WITH PLUMBER FOR

CORRECTNESS AND ACCURACY. ALL TO COMPLY TO LOCAL REGULATIONS.

- ALL COLD WATER CONNECTIONS TO SANITARY FITTINGS ARE TO BE. Ø15mm.

- ALL WASTE PIPES TO HWB'S AND SINKS ARE TO BE MIN 40MM UNLESS

OTHERWISE INDICATED.

- ALL SEWER LINES/PIPES CLOSER THAN 1m TO ANY WALL TO BE BOXED WITH - 125mm HALFROUND PVC GUTTERS WITH 76mm DOWNPIPES (VENT PIPES - 2mm,

SUB AND STACK STYLE). ALL COVER LEVELS TO BE A MIN. OF 76mm ABOVE THE NORMAL GROUND LEVEL.

ALL DRAINAGE PIPING BELOW FOUNDATIONS OR DRIVEWAYS TO BE ENCASED IN

CONCRETE.

- ALL WASTE FITTINGS TO BE ACCESSIBLE ALONG THEIR ENTIRE LENGTHS, WASTE

FITTINGS TO HAVE RE-SEAL TRAPS,
- PROVIDE AIRBRICKS TO EXT. WALL BELOW BATH.
- RE'S TP BE PROVIDED AT ALL BENDS AND JUNCTIONS,
- PLUMBER TO SUPPLY AND INSTALL STOPCOCK EXTERNALLY ACCESSON COLD

-COLD WATER TO BE 22mm POLYCOP OUTSIDE, 15mm PEX INSIDE, 15mm AT

ALL EXPOSED PIPES TO INDOOR OR OUTDOOR AIR, CONVEYING HOT WATER TO AND FROM THE HOT WATER CYLINDERS AND HEATING SYSTEMS, SHALL BE INSULATED WITH PIPE INSULATION MATERIAL WITH AN R-VALUE IN ACCORDANCE

WITH TABLE 11 AS PER SANS 10400, PART XA. SECTION 6.1
-ALL PLUMBING AND DRAINAGE MUST BE CONCEALED WITHIN THE WALLS.

(Thulatt) Checked by: H Bieldt On Behalf of WELGEDAAN SECURE ESTATE

14/04/2023

GENERAL NOTES:

MEET THE REGULATIONS OF THE LOCAL AUTHORITY AS PER BUILDING ACT 103/1977.

1.REGARDLESS OF DEPTH SHOWN ON SECTION, EXCAVATE TO A DEPTH TO PROVIDE A SOLID AND UNIFORM FOUNDATION TO ALL FOOTINGS.

2. LAY OVER ALL OPENINGS NO.2 "STRESSO" RCID LINTOLS WITH A MIN. BEARING AT EACH END OF 230mm SUPPORTED IN CENTRE FOR 5-14 DAYS.

3. LAY "BRICKFORCE" TO LINTOL MANUFACTURER'S SPECIFICATION OF MIN. 4 COURSES.

4. ALL CAVITY WALLS TO BE BUILT SOLID UP TO DPC LEVEL. 5. A MIN. OF 3 COURSES OF BRICKWORK BELOW WALL PLATES AND ABOVE ALL WINDOWS.

6. ANY FOOTINGS WITHIN 1,2m OF ANY DRAINLINE IS TO BE BELOW SAME.

7. ALL DIMENSIONS AND LEVELS TO BE SITE CHECKED PRIOR TO WORK COMMENCING.

8. GULLEY RIMS TO BE NOT LESS THAN 150mm ABOVE THE FINISHED SURROUNDING GROUND LEVEL AND NOT LESS THAN 150mm BELOW CROWN OF THE LOWEST TRAP SERVING ANY SANITARY FIXTURE.

9. DPC. TO BE MIN. 150mm ABOVE NATURAL GROUND LEVEL.(NGL)

10. THIS DRAWING IS NOT TO BE SCALED, ONLY FIGURED DIMENSIONS TO BE USED.

11. ALL WORK TO BE DONE IN ACCORDANCE WITH LOCAL AUTHORITY REGULATIONS AND BYE LAWS, ACT 103/1977 12. ALL RC SLABS, BEAMS, COLUMNS, STAIRS AND FOOTINGS TO ENGINEERS DETAIL

13. BOUNDARY WALLS TO BE DESIGNED AND BUILT IN ACCORDANCE WITH TABLE 17 AND 18 OF PART K OF THE

14. DRAINAGE AND SEWER LAYOUT TO COMPLY WITH SANS 10400P. FIRE PROTECTION TO COMPLY WITH SANS 10400T. 15. ALL CONSTRUCTION ACCORDING TO REGULATION XA COMPLIANCE REPORT.

Area & Coverage

Dwelling 106.20m² **Total Footprint** 106.20m² Plot Size 346.66m² Coverage 30.64% Boundary Wall Length 29,29m²




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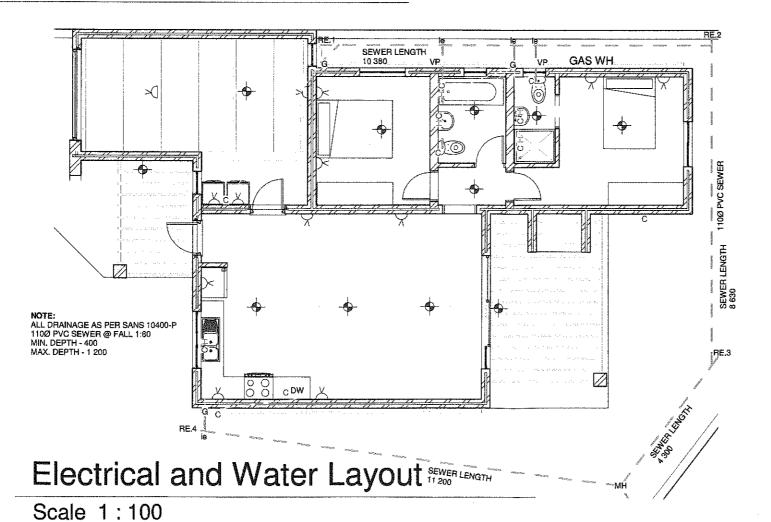
■ ARCHITE	CTURE PLA	NNING .	DESIGN
DWG TITLE:	Proposed New D On Erf 13959 Sa Saldanha Bay M For: D2SA	Idanha	-89- 1
PROJECT NUMBER:		3959SAL0	
DATE:		4	Issue

SCALE: AS SHOWN



Floor Plan

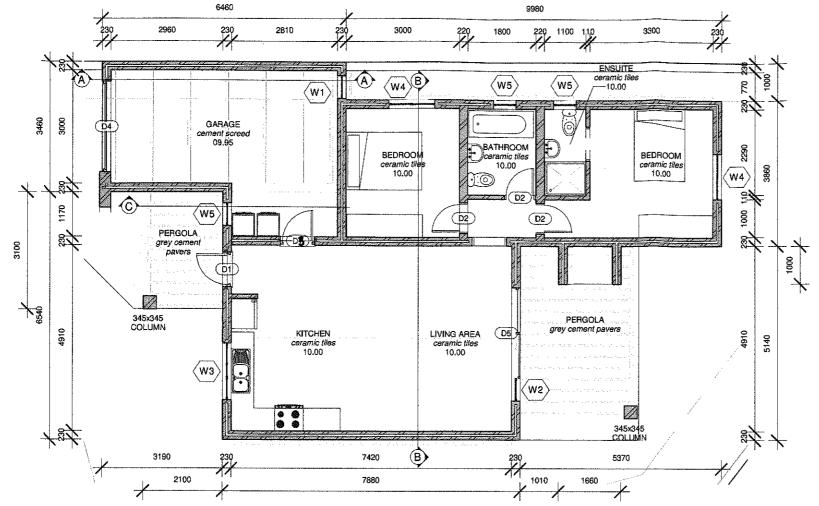Scale 1:100



Aanbeveel in terme van Artikel 6 (1) (a) van die Wet op Nasionale Bouregulasies, (Wet 103 van 1977 soos gewysig) Recommended in terms of Section 6 (1) (a) of the National Building Regulation and Building Standards, (Act 103 of 1977 as amended)

Boubeheerbeampte
Building Control Offices

Goedgekeur in terme van Artikel 7 (1) (a) van die Wet op Nasionale Bouregulasies en Boustandaarde, (Wet 103 van 1977 soos gewysig) vir 12 maande. Approved in terms of section 7 (1) (a) of the National Building Regulations, (Act 103of 1977 as scoondail (c) 17 and 1877 as scoondail (c) 17 and 17

09/06/2023 Datum

(Thislott) Checked by: H Bieldt On Behalf of WELGEDAAN SECURE ESTATE

14/04/2023




Principal Member: Hanrich Bieldt SACAP Reg. No: PAD38130947

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DWG TITLE:	CTURE PLANNI Proposed New Dwellin	<u> </u>	DESIGN
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	Saldanha Bay Mun.	A A	S
	For: D2SA		ئىن ب
PROJECT NU	MBER:	4 4	13959SAL01
DATE:			Issue D

SCALE: AS SHOWN

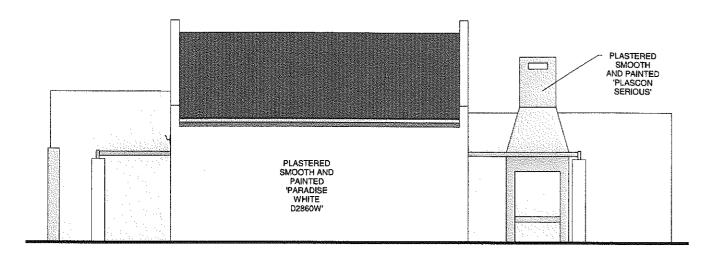

PLASTERED SMOOTH AND PAINTED 'PARADISE WHITE D2860W'

Southern Elevation

Scale 1:100


Aanbeveel in terms van Artikel 6 (1) (a) van die
Wet op Nasionale Bouregulasies, (Wet 103 van 1977 soos gewysig)
Recommended in terms of Section 6 (1) (a) of the National Building Regulations
and Building Standards, (Act 193 of 1977 as amended)

7/6/2023

Goedgekeur in terme van Artikel 7 (1) (a) van die Vet op Nasionale Bouregulasies en Boustandaarde, (Wet 103 van 1977 soos gewysig) vir 12 maande. (Wet 103 van 1977 soos gewysig) vir 12 maande. (Act 103 of 1977 as amended) Por 12 markins A


Boubeheerbeampte Building Control Officer

09/06/2023

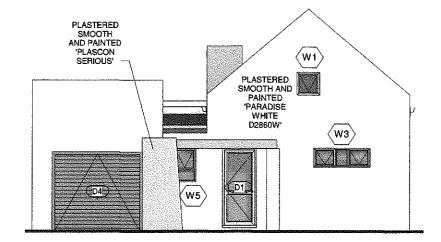

Western Elevation

Scale 1:100

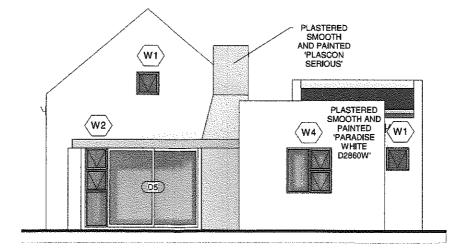

Eastern Elevation

Scale 1:100

Northern Elevation

Scale 1:100

Checked by: H Bieldt
On Behalf of
WELGEDAAN
SECURE ESTATE

14/04/2023



Principal Member: Hanrich Bield! SACAP Reg. No: PAD38130947

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■ ARCHITECTURE ■ PLANNING ■

Proposed New Dwelling On Erf 13959 Saldanha Saldanha Bay Mun.

For: D2SA

PROJECT NUMBER:

13959SAL0106

DATE:

SCALE:

DWG TITLE:

Issue Date

DESIGN **C**

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AS SHOWN

ROOF -§* PITCH AZ-200 CHROMODECK, CORRUGATED METAL ROOF SHEETING, COLOUR - Light Grey, ON SISALATION ON 38X152mm SA PINE PURLIN RAFTERS @ MAX 1000mm C/C FIXED TO WALL WITH TRUSSHANGERS. RAIN WATER GOODS: 90mm "D" SHAPE SEAMLESS ALU, GUTTER, COLOR - Light Grey & 75mm DIAMETER RAINWATER DOWN PIPE ON Light Grey PAINTED 223mmx20mm FIBER CEMENT FACIA FLOOR CONSTRUCTION: 50mm WELL COMPACTED GRANO ON MIN 90mm 15 MPa CONCRETE ON 250 MICRON DPC ON 40mm SAND BLINDING ON WELL COMPACTED FILLING FREE FROM CLAY AND OTHER ORGANIC MATERIAL. NGL DPC 09.95 PC STRIP FOUNDATION @ MIN 300 BELOW NGL AS PER ENG, DETAIL AS PER ENG, DETAIL


Section A

Scale 1:100

ROOF -5° PITCH AZ-200 CHROMODECK, CORRUGATED METAL ROOF SHEETING, COLOUR - Light Grey. ON SISALATION ON 50X76mm PURILINS @ MAX 900mmC/C ON 38X114mm SA PINE RAFTER @ MAX 1000mm C/C FIXED TO 114X38mm WALL PLATE BUILT IN WITH GALVANISED HOOP IRON 600mm INTO WALL. RAFTERS FIXED TO WALL WITH GALV. TRUSSHANGERS. RAIN WATER GOODS: 90mm "D" - SHAPE SEAMLESS ALU. GUTTER, COLOR - Light Grey & 75mm DIAMETER RAINWATER DOWN PIPE ON Light Grey PAINTED 223mmx20mm FIBER CEMENT FACIA PEGOLA: 38X114 SA PINE RAFTERS ON TRUSSHANGER FIXED TO WALL AND TO 50X228 BEARER BEAM BUILT INTO WALL AND FIXED TO 345X345 COLUMN. FLOOR CONSTRUCTION: 50mm WELL COMPACTED GRANO ON MIN 90mm 15 MP2 CONCRETE ON 250 MICRON DPC ON 40mm SAND BLINDING ON WELL COMPACTED FILLING FREE FROM CLAY AND OTHER ORGANIC MATERIAL.

Section C

Scale 1:100

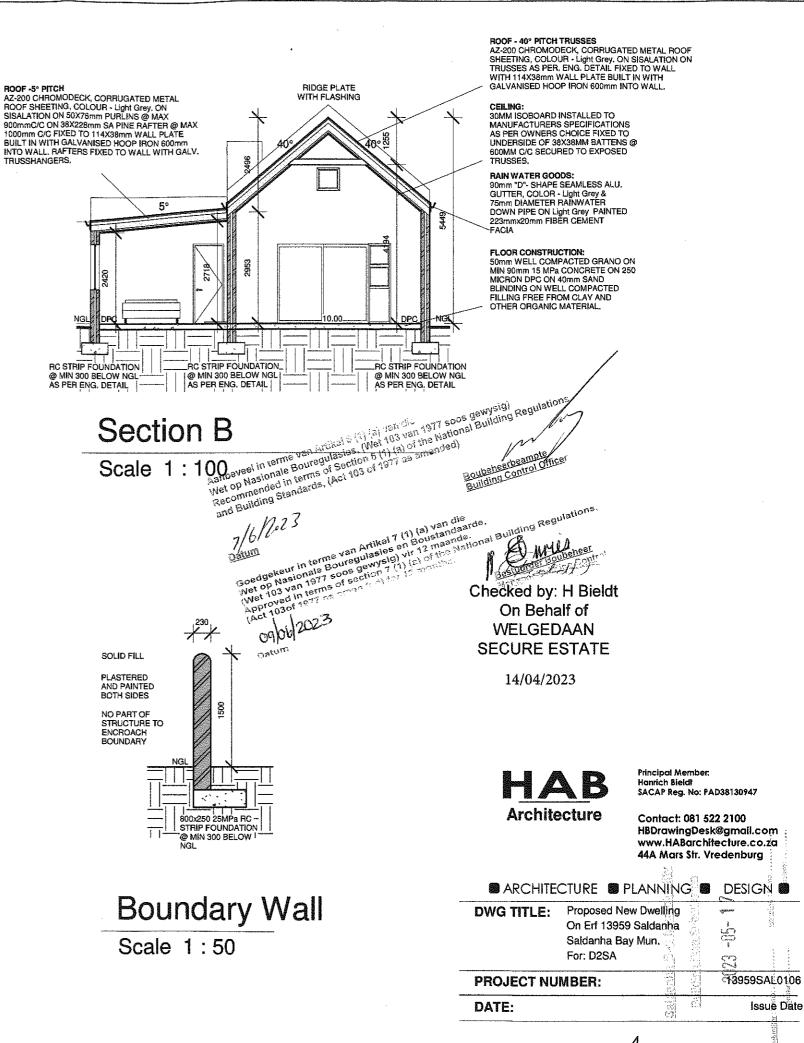

SCALE: AS SHOWN

View	Door Number	Width	Height	Material	Area of Glazing
	D.1	910	2110	Dust Grey Powder Coated Aluminium	1.6
	D.2	810	2 110	Hollow core	N/A
	D.3	810	2 110	Fire Door With Self Closing Device	N/A
	D.4	4 800	2 110	Dust Grey Powder Coated Aluminium	N/A
	D.5	3 600	2 110	Dust Grey Powder Coated Aluminium	5.04
				Total Area of Glazing	6.64m²

View	Window Number	Туре	Width	Height	Material	Count	Area of Glazing
	W.1	PT66	600	600	Dust Grey Powder Coated Aluminium	3	0.72
	W.2	PTT621	600	2 100	Dust Grey Powder Coated Aluminium	1	1.26
M M	W.3	PTT155	500	1 500	Dust Grey Powder Coated Aluminium	1	0.75
	W.4	PTT1212	1 200	1 200	Dust Grey Powder Coated Aluminium	2	2.88
	W.5	PT69	600	900	Dust Grey Powder Coated Aluminium	3	1.62
						Total Area of Glazing	8.67m²

Door Schedule

Scale 1:100

Window Schedule

Scale 1:100

Aanbeveel in terms van Artiket = (%) (a) van li... Wet op Nasionale Bouregulasies, (Wet 103 van 1977 soos gewysig) Recommended in terms of Section 6 (1) (a) of the National Building Regulations and Building Standards, (Act 103 of 1977 as amended)

07/06/2013 Datum

<u>Boubeheerbeampte</u>

Goedgekeur in terme van Artikel 7 (1) (a) van die Wet op Nasionale Bouregulasies en Boustandaarde, (Wet 103 van 1977 soos gewysig) vir 12 maande.

Approved in terms of section 7 (1) (a) of the National Building Regulations, (Act 103of 1977 as appoint 1) for the National Building Regulations.

09/06/2023



(Theolot) Checked by: H Bieldt On Behalf of **WELGEDAAN** SECURE ESTATE

14/04/2023

XA Compliance report

Occupnacy: H4 Climate zone: 4

Temporal Coastal

Lighting and Power LED to comply with SANS 10400 XA

Hot water services
Electrical resistance heating elements may not exceed 50% of annual average hot water requirements by volume as per SANS 10400 XA

≥270kg/m²

Floors
Min. Insulation R-value: 1.0m².K/W as per SANS 10400 XA

External Wall Construction as per Sans 10400 XA Wall type: Masonry

Min. requirements for external walls other than Category 1 Buildings

Energy Zone

R-Value (m².K/W) 0.6

Min. requirement

50mm cavity wall

-Single-leaf masonry walls in category 1 buildings shall have a nominal wall thickness greater of equal to 140mm

Roof Construction
To comply with SANS 10400 XA

Min. required Totoal R-Value (m²,K/W): 3.7 Direction of heat flow: Up Est. minimum added R-Value of insulation (m²,K/W): 3.35

Generic Insulation

Glass wool blanket Density: 10 to 18 kg/m² Thickness: 135mm

Building sealing as per SANS 10400 XA

Glazing % in relations to Net Floor Area

CHOCKING / P III / CICKIC/	
Net Floor Area	72.00m²
Windows	7.23m²
Doors	6.64m²
Total Area Glazing	13.87m²
Glazing %	19.26%

Glazing requirements as per SANS 10400 XA Fenestration

		Maximum solar heat gain coefficient (SHGC)				
Total fenestration area for each storey/nett floor area for each storey (%)	U-Value (W/m².K)	Vertical fenestrat North- West, Nort East sector orien	Vertical fenestration with South-West, South and South-Eastern			
		With shading in	With no shading or			
		accordance with 5.2.2 of SANS 10400 XA	not in accordance with 5.2.2 of SANS 10400 XA	All		
≤ 20 %	Any Solution	Any Solution	Any Solution	Any Solution		
≤ 25 %	5,20	0,66	0,49	Any Solution		
≤ 30 %	4,40	0,53	0,44	Any Solution		

Architecture

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■ ARCHITECTURE ■ PLANNING ■ DESIGN ■

DATE:

SCALE:

DWG TITLE: Proposed New Dwelling

On Erf 13959 Saldanha Saldanha Bay Mun. For: D2SA

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PROJECT NUMBER:

₫3959SAL0106 Issue Date

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AS SHOWN